



 FORMLINE ARCHITECTURE 94 Marine Drive Suite 1410 West Vancouver, BC V7T 1A8 T. 604.922.2020 E. info@formline.ca W. www.formline.ca	 city of Quesnel	QUESNEL INDIGENOUS CULTURAL CENTRE PRE-DESIGN STUDY	project code 18001	status DRAFT checked AW M&K	CONCEPT DESIGN OPTION B scale NTS 2018.12.13	drawing number P00 revision
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DESIGN CONCEPT






The design concept for the Quesnel Indigenous Cultural Centre defines its cultural pedigree from the Phinose village seen by the Dene in the Plateau region along the Fraser River. Archaeologists estimate that mobile hunting people travelled to semi-permanent villages using Phinose structures around 2,500 B.C. The Dene in this region were along major water ways including the Fraser River and harvesting of salmon was central to their culture. Phinose structures are developed in various forms and the more common structure had four supporting poles and 12 main beams.

The Cultural Centre is conceived as a Phinose village located where the Quesnel River meets into the Fraser River. It is conceived as a phinose emerging out of the existing Cedar Tingley Memorial Park green field forming a village housing a theatre in the round, a cultural exhibit centre, and a gift store. Outside the village is a structural frame of a Phinose symbol referencing the historical precedent. Sipiŋi space surrounds the 5 main spaces and a horizontal roof plane connects each structure.

To preserve the nature of the park the planted roof building has access to a roof observation deck allowing visitors a vantage point of the Fraser River. The building merges with the landscape growing out of the site. Each pole house structure will be crowned with a natural ventilation and sky light device to provide day lighting and natural ventilation to the building interior.


The entrance of the Cultural Centre faces the five front trail and is aligned with Voyageur Rock, a symbolic reference natural link between the Fraser River and human cultures which exist along its banks. Parking and a drop off area accommodate access to the existing boat launch. Additional parking will be provided across the Front Street and at the existing RV drop off.

The existing River Front trail flows through the site and engages a look out plaza with a sculptural phinose located in the centre. This space is a multi-functional space used for markets and gathering. The Phinose structure is an old idea, however this can be replaced by light structure evocative of a fish drying structure to provide weather protection for kiosks. The building form wraps around this space forming a semicircular courtyard. A cafe faces south directed to the point where the Quesnel River meets the Fraser. There is easy access from the river path and easy access to the existing picnic area on the lower bank. To enhance the use of the picnic area 12m diameter concrete pads and picnic tables will be added. A universal washroom provides access to the park as well as the Cafe.

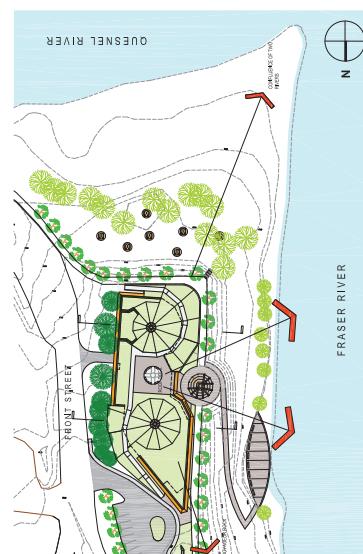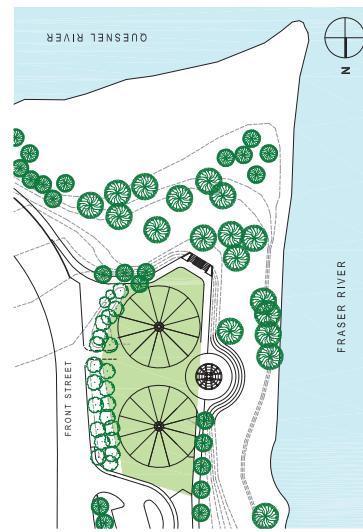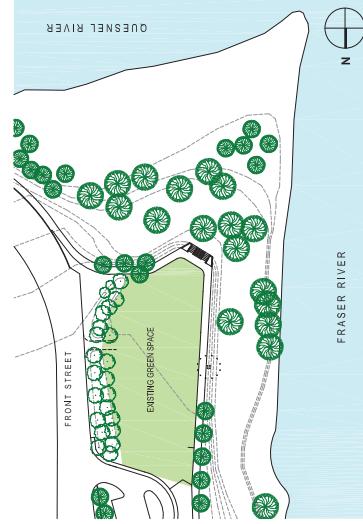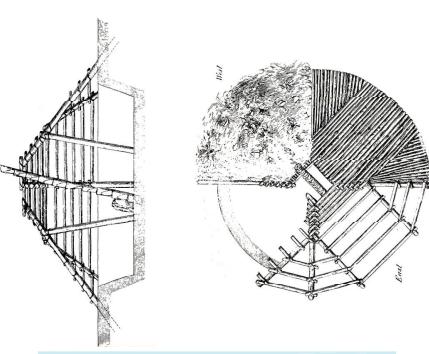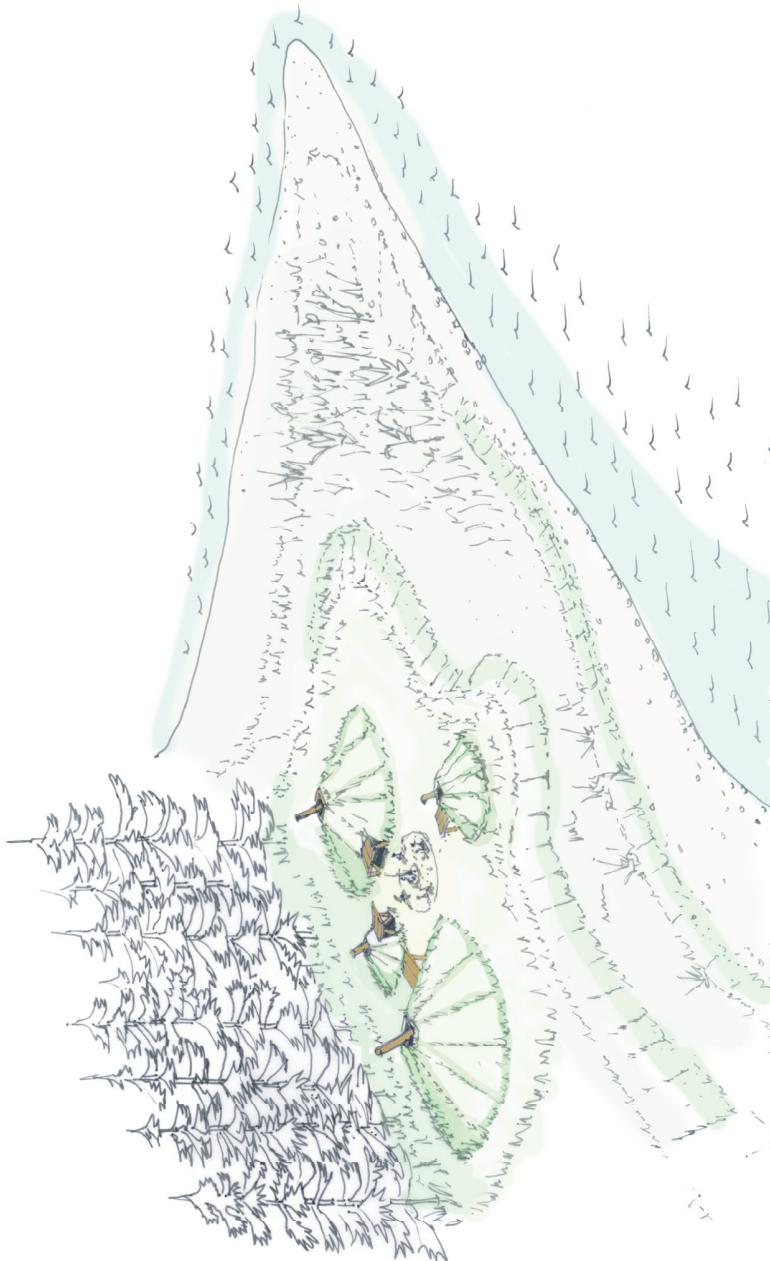




FORMLINE ARCHITECTURE	city of Quesnel	QUESNEL INDIGENOUS CULTURAL CENTRE	DESIGN CONCEPT	drawing number
94 Marine Drive Suite 1410 West Vancouver, BC V7T 1A8 T. 604.922.2020 E. info@formline.ca W. www.formline.ca		PRE-DESIGN STUDY	DRAFT checked AW NTS MK	P02b revision



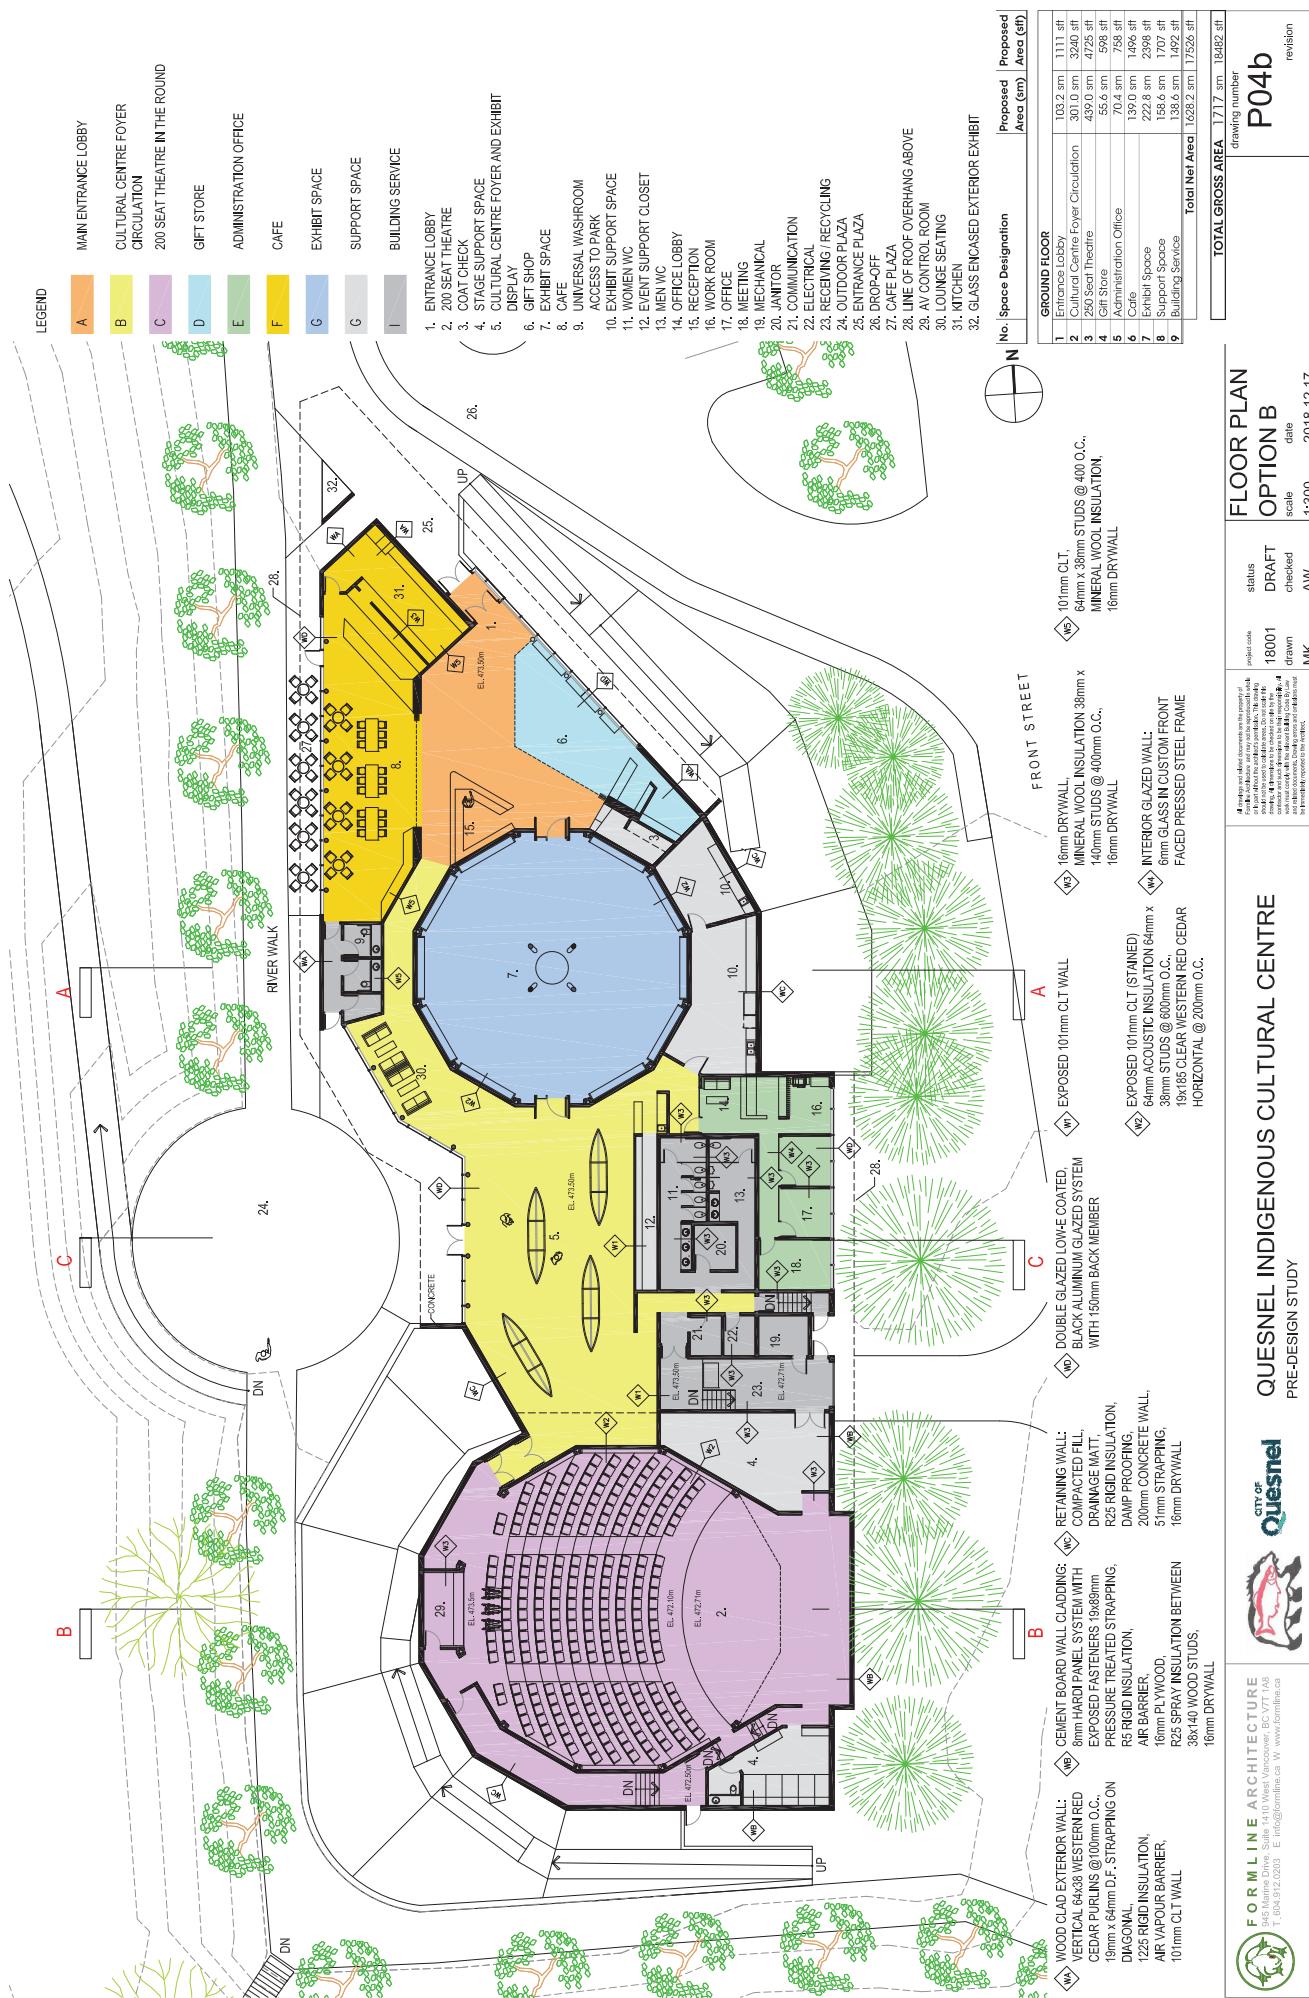

LEGEND

1. DOUBLE 48x75 GLULAM BEAMS
2. 19mm STAINED CLT PANEL (SLOPED ROOF)
3. 260mm TANED CLT PANEL (FLAT ROOF)
4. PAINTED DRYWALL SUSPENDED CEILING
BACKED BY STEEL STUD FRAMING

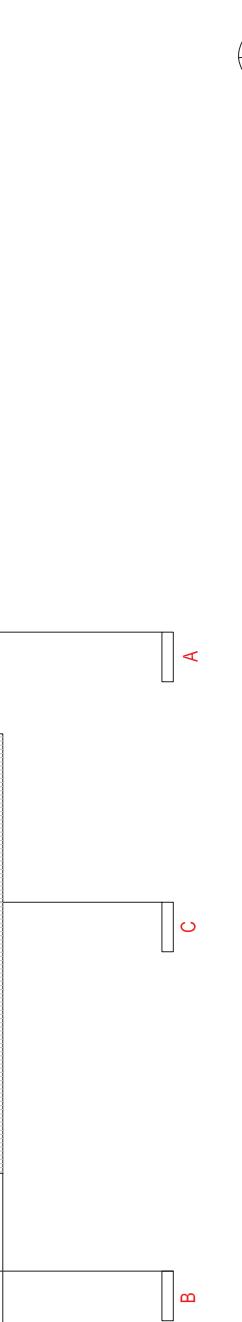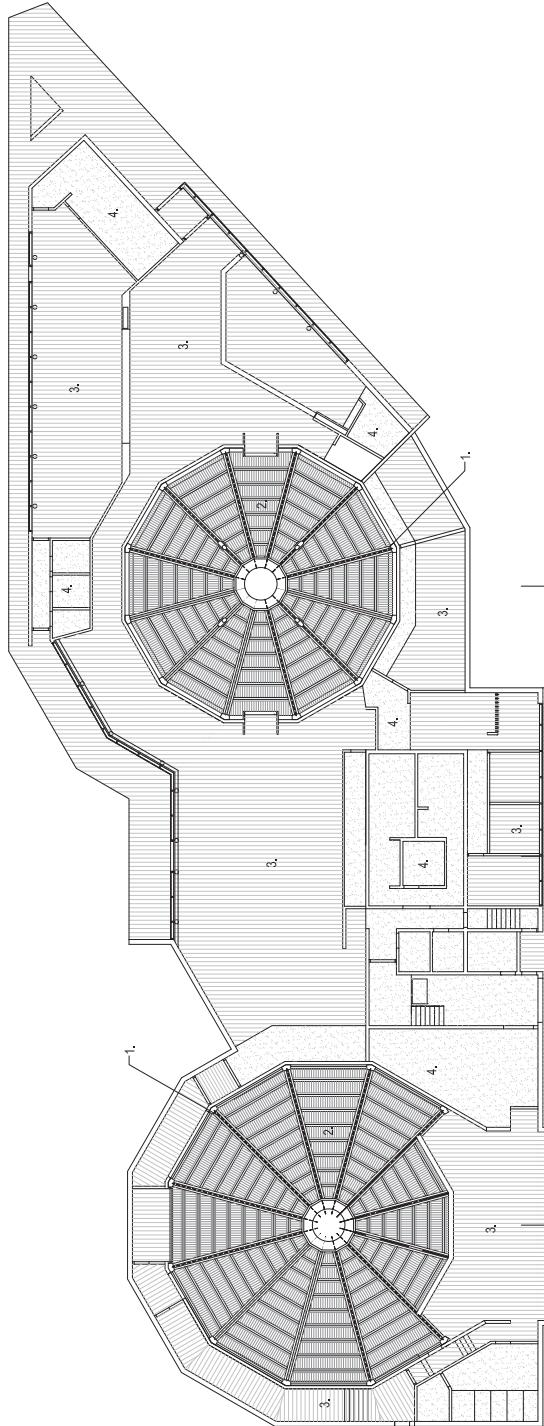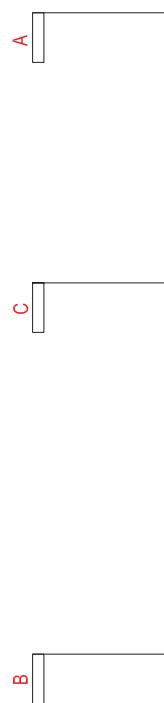

QUESNEL INDIGENOUS CULTURAL CENTRE
PRE-DESIGN STUDY



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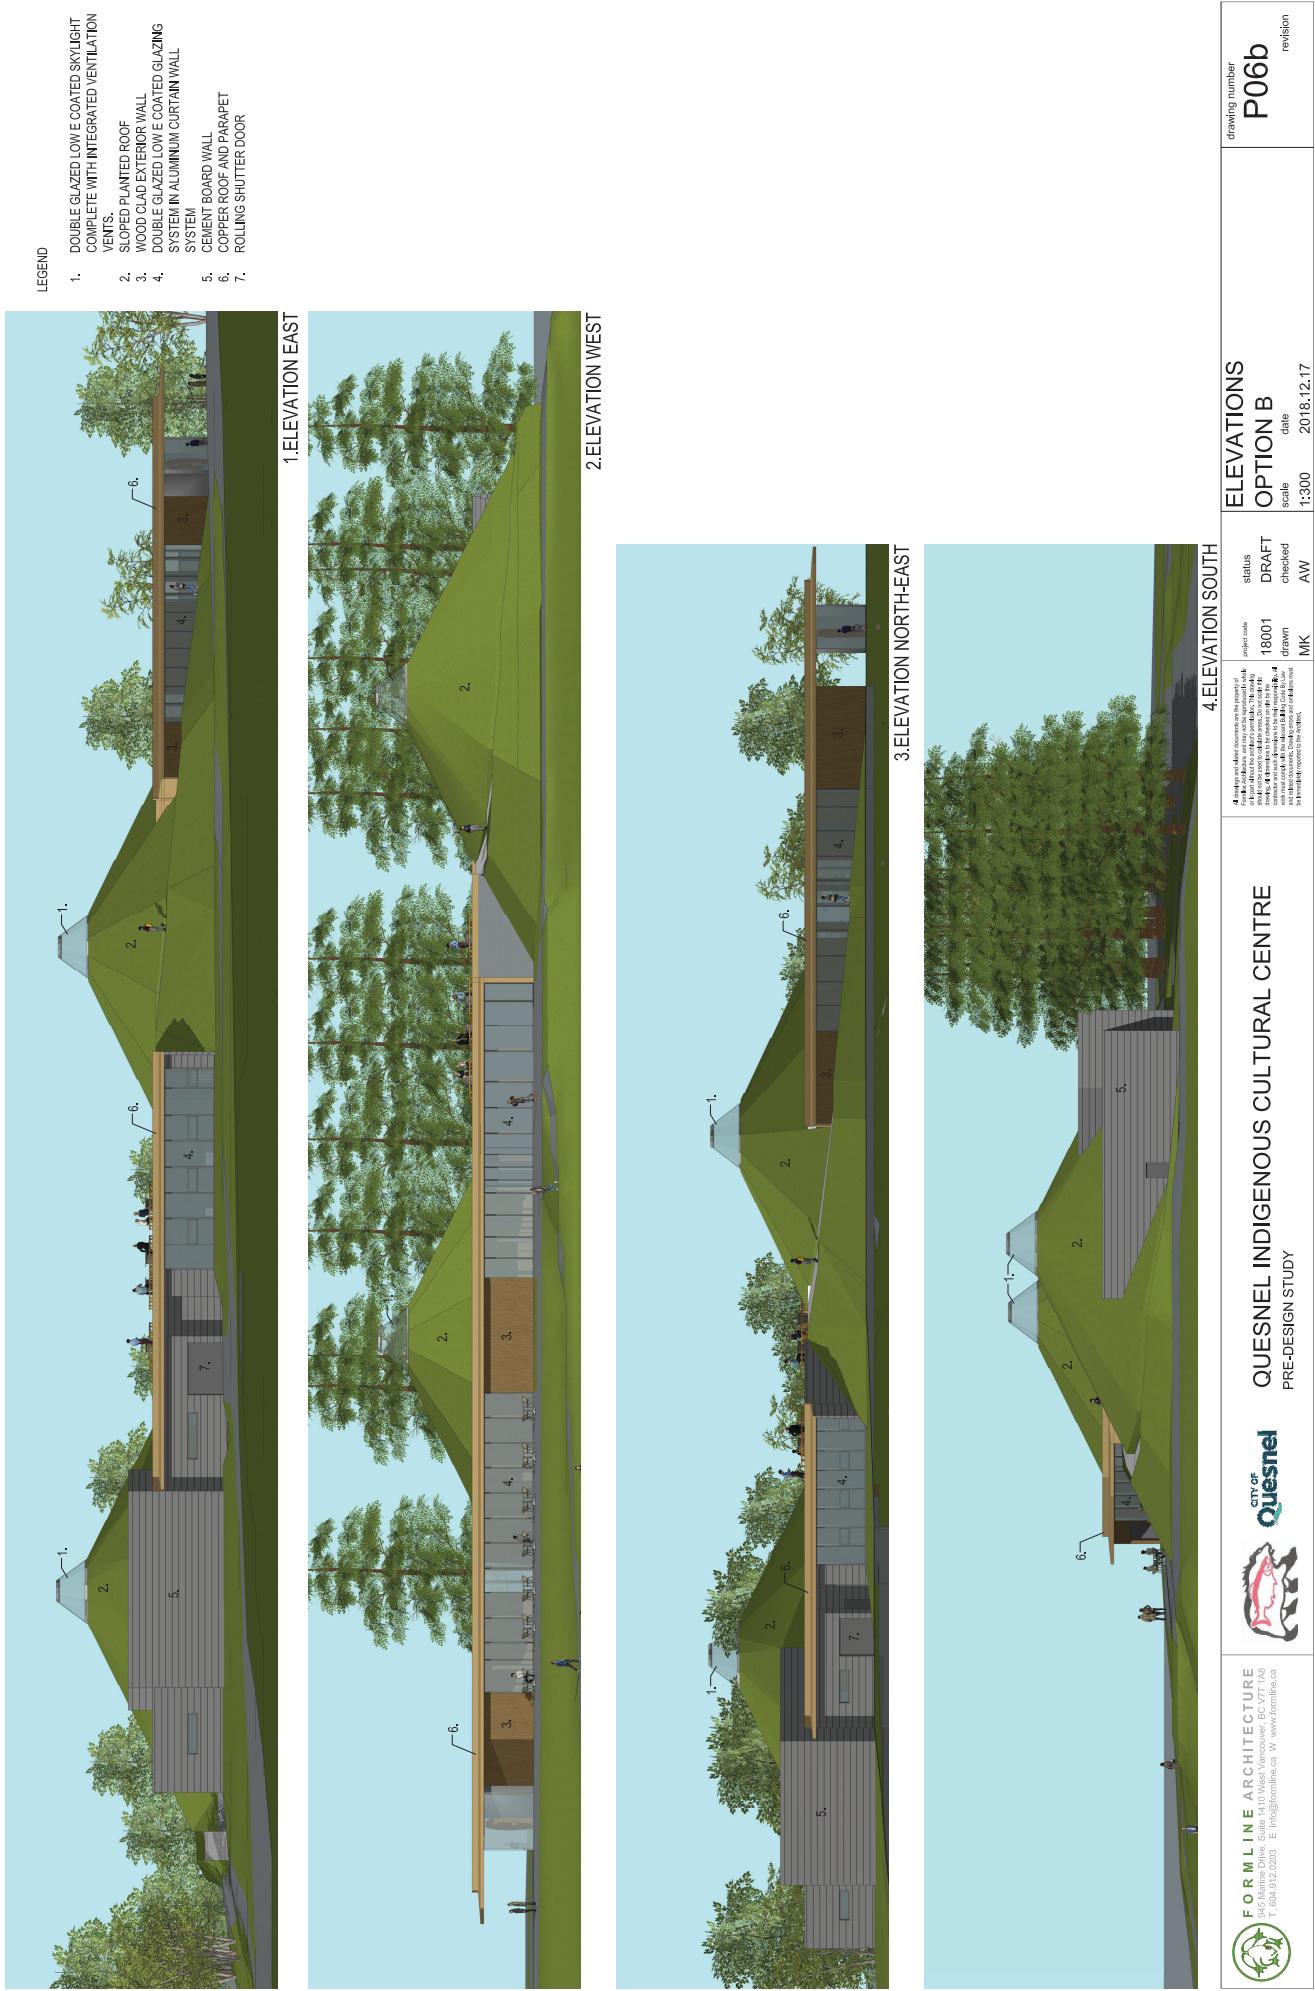


REFLECTED CEILING PLAN
OPTION B

scale
date



1:300 2018.12.17

drawing number
P05b
revision



LEGEND

1. DOUBLE GLAZED LOW COATED SKYLIGHT COMPLETE WITH INTEGRATED VENTILATION
 2. SLOPED PLANTED ROOF ASSEMBLY:
WILD GRASSES; 150mm LIGHT WEIGHT GROWING MEDIUM, PERFORATED TRAY, FILTER FABRIC, ROOT BARRIER, DRAINAGE MATT, P80 RIGID INSULATION, 2P1 SBS MEMBRANE, 10mm CLT PANEL, 10x1250 DOUGLAS FIR PURLINS @ 100mm O.C., DOUBLE 30 x 300mm GULUM BEAMS PLANTED FLAT ROOF ASSEMBLY:
WILD GRASSES; 150mm LIGHT WEIGHT GROWING MEDIUM, FILTER FABRIC, ROOT BARRIER, DRAINAGE MATT, R25 RIGID INSULATION, 2P1 SBS MEMBRANE, 260mm CLT PANEL
 3. PLANTED FLAT ROOF ASSEMBLY:
WILD GRASSES; 150mm LIGHT WEIGHT GROWING MEDIUM, FILTER FABRIC, ROOT BARRIER, DRAINAGE MATT, R25 RIGID INSULATION, 2P1 SBS MEMBRANE, 260mm CLT PANEL
 4. WOOD CLAD EXTERIOR WALL ASSEMBLY:
VERTICAL 64 x 38 WESTERN RED CEDAR PURLINS @ 100mm O.C., 19 x 64mm D.F., STRAPPING ON DIAGONAL, R25 RIGID INSULATION AIR/WAVOUR BARRIER, 10mm CLT WALL Panel
 5. TYPICAL GLAZED WALL SYSTEM: DOUBLE GLAZED LOW COATED LAZING SYSTEM IN ALUMINUM CURTAIN WALL SYSTEM WITH 10MM BACK MATER, VERTICAL SILICON JOINTS.
 6. SUBTERRANEAN WALL SYSTEM: COMPACTED FILL, DRAINAGE MAT, 25 RIGID INSULATION, DAM PROOFING, 20mm CONCRETE WALL, 5mm STRAPPING, 16mm DRYWALL, CEMENT BOARD WALL SYSTEM:
8mm HARDBOARD PANEL SYSTEM WITH EXPOSED FA FASHERS, 19 x 89mm PRESSURE TREATED STRAPPING, RS RIGID INSULATION, AIR BARRIER, 6mm PL MWOOD, R25 SPRAY INSULATION BETWEEN 38 x 400 WOOD STUDS, 16mm DRYWALL.
 7. CEMENT BOARD WALL SYSTEM:
8mm HARDBOARD PANEL SYSTEM WITH EXPOSED FA FASHERS, 19 x 89mm PRESSURE TREATED STRAPPING, RS RIGID INSULATION, AIR BARRIER, 6mm PL MWOOD, R25 SPRAY INSULATION BETWEEN 38 x 400 WOOD STUDS, 16mm DRYWALL.
 8. 300mm DIAMETER TURNED DOUGLAS FIR COLUMNS
 9. 130 x 350 DOUBLE GULUM COLUMNS
 10. 150mm FLOOR SLAB ON GRADE WITH RADIANT HEATING, 10mm VAPOUR BARRIER, R20 RIGID INSULATION
 11. 250mm DIAMETER DOUGLAS FIR COLUMN

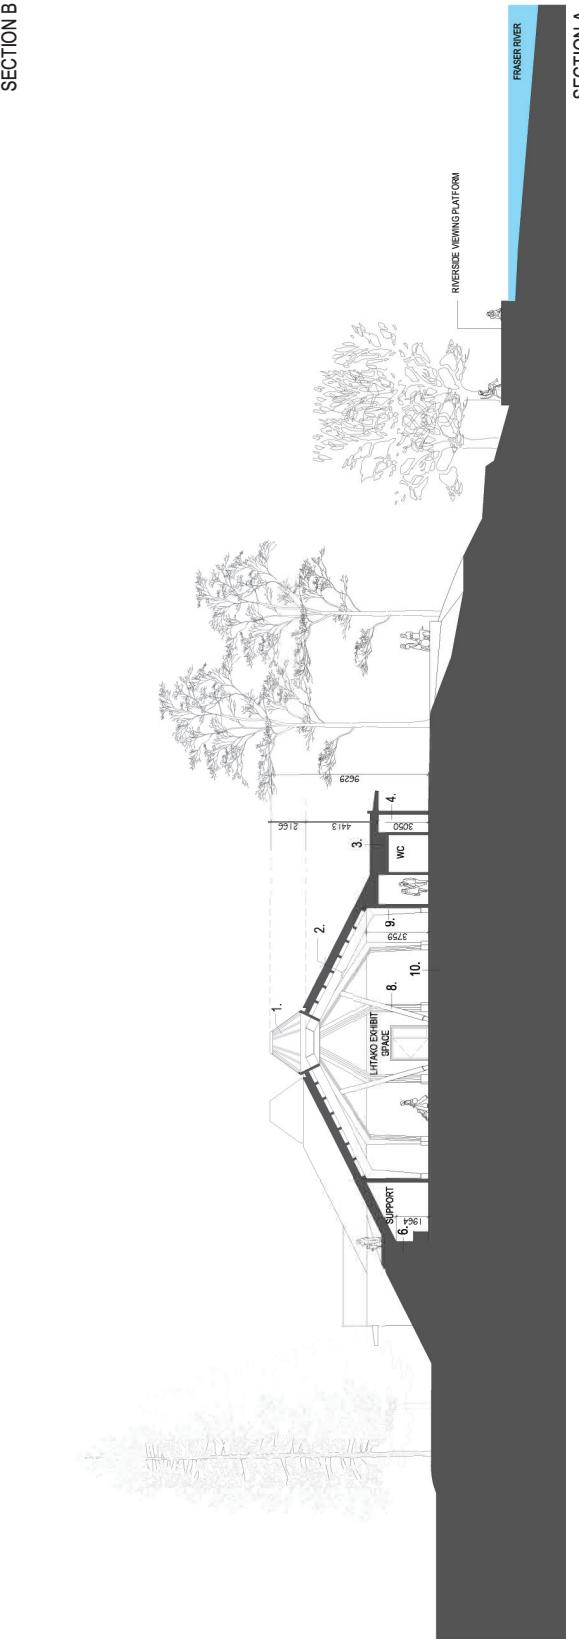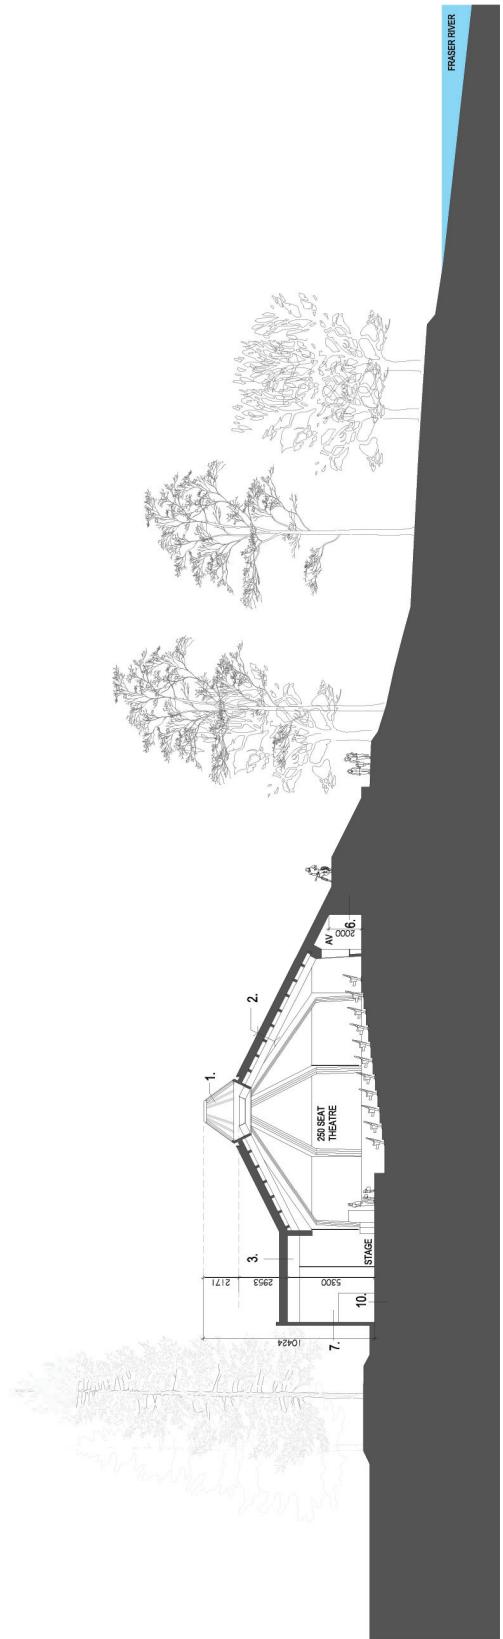


SECTION A

LEGEND

1. DOUBLE GLAZED LOW E COATED SKYLIGHT COMPLETE WITH INTEGRATED VENTILATION VENTS.
2. SLOPED PLANTED ROOF ASSEMBLY:
WILD GRASSES; 150mm LIGHT WEIGHT FILTER FABRIC ROOT BARRIER, DRAINAGE MAT, R30 RIGID INSULATION, 2PL 98S MEMBRANE, 10mm CLT PANEL, 170x250 DOUGLAS FIR PURLINS @ 1000mm O.C., DOUBLE 130 x 300 GLULAM BEAMS.
3. PLANTED FLAT ROOF ASSEMBLY:
WILD GRASSES; 150mm LIGHT WEIGHT GROWING MEDIUM, FILTER, FABRIC ROOT BARRIER, DRAINAGE MAT, R25 RIGID, 280mm CLT PANEL.
4. WOOD CLAD EXTERIOR WALL ASSEMBLY:
VERTICAL 64 X 38 WESTERN RED CEDAR PURLINS @ 100mm O.C., 19.64mm DF., STRAPPING ON DIAGONAL, R25 RIGID INSULATION, AIR / VAPOUR BARRIER, 101mm CLT WALL Panel.
5. TYPICAL GLAZED WALL SYSTEM: DOUBLE GLAZED LOW E COATED GLAZING SYSTEM IN ALUMINUM CURTAIN WALL SYSTEM WITH 100mm BACK MEMBER, VERTICAL SILICON JOINTS.
6. SUBTERRANEAN WALL SYSTEM:
CEMENT BOARD WALL SYSTEM: COMPACTED FILLED DRAINAGE MAT, R25 RIGID INSULATION, DAMP PROOFING, 16mm CONCRETE WALL, 51mm STRAPPING, 16mm DRYWALL.
7. CEMENT BOARD WALL SYSTEM:
8mm HARO PANEL SYSTEM WITH EXPOSED FASTENERS, 19 X 98 PRESSURE TREATED STRAPPING, RIGID INSULATION, AIR BARRIER, 16mm PLYWOOD, R24 SPRAY INSULATION BETWEEN 38 X 140 WOOD STUDS, 16mm DRYWALL.
8. 300mm DIAMETER TURNED DOUGLAS FIR COLUMNS
9. TAPERED 130 X 360 DOUBLE GLULAM COLUMNS
10. 125mm FLOOR SLAB ON GRADE WITH RADIANT HEATING, 0.0mil/VAPOUR BARRIER, R20 RIGID INSULATION
11. 250mm DIAMETER DOUGLAS FIR COLUMN

SECTION B

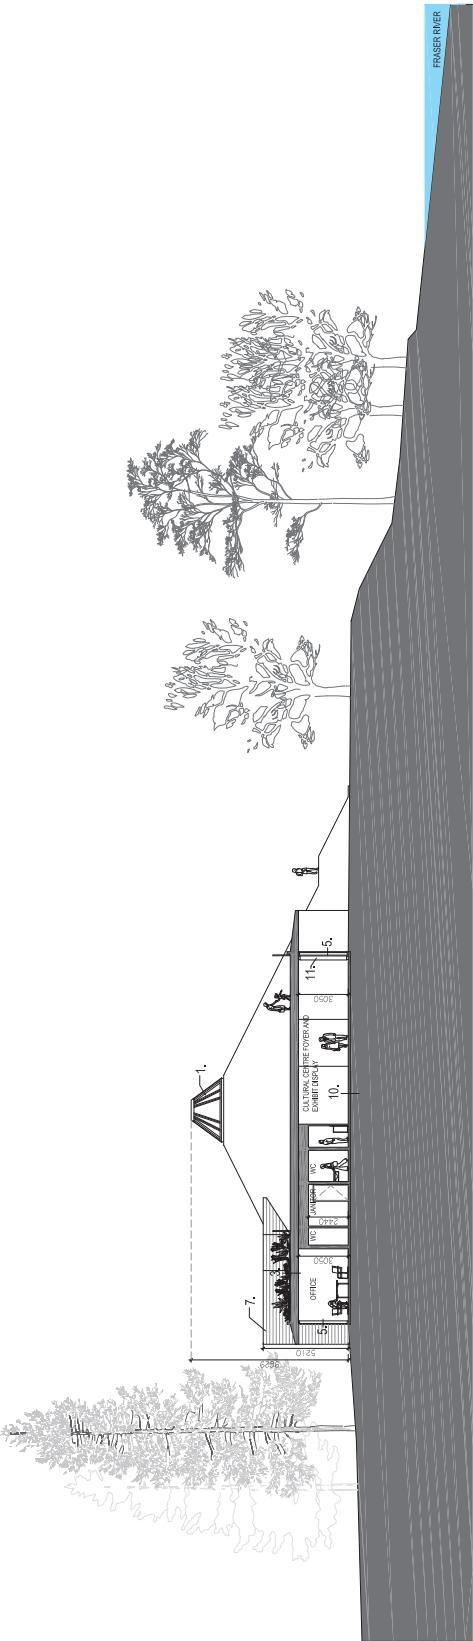

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	city of Quesnel	QUESNEL INDIGENOUS CULTURAL CENTRE PRE-DESIGN STUDY	FORMLINE ARCHITECTURE 945 Marine Drive, Suite 1410 West Vancouver, BC V7T 1A8 T 604.912.0203 • E info@formline.ca • W www.formline.ca	CONCEPT DESIGN OPTION B scale date NTS 2018.12.13	status DRAFT checked AW MK	drawing number P09b révision
<small>All drawings established coordinate with the property boundary. This drawing is not to scale and is for illustrative purposes only. The drawing is to be used as a reference document only. Do not use this drawing for construction or engineering purposes. All representations shown in this drawing are subject to change at the discretion of the architect. Any changes made to the design or representation of the building must be done in accordance with the architect's instructions. Changes made to the design or representation of the building without the architect's written consent, shall be deemed to be unauthorized.</small>						



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<p>All drawings established according to the property line and lot dimensions as shown on the survey plan. The drawing is for your information only and is not to be used as a permit drawing. The drawing is to be used as a reference to the survey plan. All representations shown on the drawing are approximate and are not to be used as a permit drawing. The drawing is to be used as a reference to the survey plan. All representations shown on the drawing are approximate and are not to be used as a permit drawing. The drawing is to be used as a reference to the survey plan.</p>					